# Photovoltaic Roof Mount System

30 MODULES-ROOF MOUNTED - 11.10 kWp DC / 9.75 kVA AC


3505 Medulla Rd., Plant City FL 33566

#### **SCOPE OF WORK:**

SYSTEM SIZE: 11.10 KW DC, 9.75 KVA AC
PV MODULES: BVM6610M-370S-H-HC-BF
INVERTER (S): 30 x Enphase IQ8M-72-2-US
RACKING STRUCTURE: S-5! ProteaBracket with PVKIT
ATTACHMENT: N/A

NEC 2017, IBC 2014, IFC 2014, IRC 2014

This approval is for compliance to the current adopted building codes for the proposed Solar System only. It is the owner's/applicant's responsibility to ensure that the proposed installation of solar systems and associated equipment is on legally permitted structures. If determined by inspection staff the proposed solar system is installed on non-permitted structures, any required modifications needed for code compliance will be at the owner's/applicants expense.

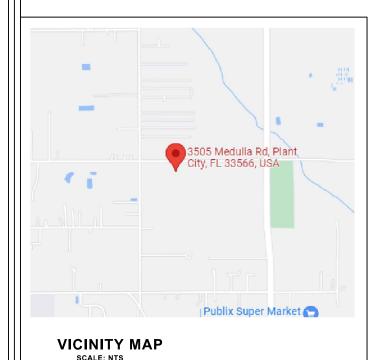

#### **GENERAL NOTES:**

- LOCAL UTILITY PROVIDER SHALL BE NOTIFIED PRIOR TO USE AND ACTIVATION OF ANY SOLAR PHOTOVOLTAIC INSTALLATION.
- THIS PROJECT SHALL COMPLY WITH LOCAL ORDINANCES.
- PROPER ACCESS AND WORKING CLEARANCE WILL BE PROVIDED.
- ALL ELECTRICAL WORK SHOWN ON THESE PLANS WILL BE COMPLETED BY THE UNDERSIGNED.
- ALL APPLICABLE PV EQUIPMENT LISTED AND COMPLIANT WITH UL2703, UL1741 AND UL1703.
- ALL ROOF PENETRATIONS TO BE SEALED WITH A HIGH PERFORMANCE ROOF SEALANT SUCH AS GeoCel 2300 CLEAR SEALANT.
- THE SYSTEM WILL NOT BE INTERCONNECTED UNTIL APPROVAL FROM THE LOCAL JURISDICTION AND THE UTILITY IS OBTAINED.
- THE SOLAR PHOTOVOLTAIC INSTALLATION SHALL NOT OBSTRUCT ANY PLUMBING, MECHANICAL, OR BUILDING ROOF VENTS.

  IF THE FXISTING MAIN PANEL DOES NOT HAVE VERIFIABLE GROUNDING.
- IF THE EXISTING MAIN PANEL DOES NOT HAVE VERIFIABLE GROUNDING ELECTRODE, IT IS THE NECESSARY TO INSTALL A SUPPLEMENTAL GROUNDING ELECTRODE.
- EACH MODULE WILL BE GROUNDED UL 2703 OR UL 1703 APPROVED USING THE SUPPLIED CONNECTION POINTS IDENTIFIED ON THE MODULE AND THE MANUFACTURER'S INSTALLATION INSTRUCTIONS".
- A LADDER SHALL BE IN PLACE FOR THE INSPECTION IN COMPLIANCE WITH OSHA REGULATIONS.
- MAX HEIGHT OF MODULES OFF OF ROOF FACE: <6".</li>
- ALL WORK SHALL COMPLY WITH 2011 NEC, 2012 IRC, IBC 2012, 2012 IFC MUNICIPAL CODE, AND ALL MANUFACTURERS' LISTINGS AND INSTALLATION INSTRUCTION..
- PHOTOVOLTAIC SYSTEM WILL COMPLY WITH 2011 NEC.
- PHOTOVOLTAIC SYSTEM INVERTER IS UNGROUNDED. NO CONDUCTORS ARE SOLIDLY GROUNDED IN THE INVERTER, AND SYSTEM COMPLIES WITH 690.35.
- MODULES CONFORM TO AND ARE LISTED UNDER UL 1703.
- INVERTER CONFORMS TO AND IS LISTED UNDER UL 1741.
- ELECTRICAL EQUIPMENT AND MATERIAL TO BE LISTED, LABELED, AND INSTALLED PER THE NEC, THE INSTALLATION STANDARDS/MANUFACTURER'S RECOMMENDATIONS AND IF REQUIRED A RECOGNIZED ELECTRICAL TESTING LABORATORY.
- CONDUITS EXPOSED TO SUNLIGHT ON ROOF SHALL BE LOCATED NOT LESS THAN 7/8" ABOVE ROOF SURFACE.

TABLE OF CONTENT	
PV-00	COVER SHEET
PV-01	SITE & ROOF PLAN
PV-02	ROOF & MODULES PLAN
PV-03	STRING LAYOUT
PV-04	MOUNTING LAYOUT
PV-05	SINGLE-LINE DIAGRAM
PV-06	THREE-LINE DIAGRAM
PV-07	METER & PANEL PHOTOS
PV-08	WARNING SIGNS
Appendix	Datasheets

## **BEAM SEQUENT**

Engineering & Consultaion Al-Quds Street Ramallah, Palestine www.beamsequent.com

## Project Data

Tyrell Hicks Residence PV System

27°58'53.33"N 82° 3'41.81"W

3505 Medulla Rd. Plant City FL 33566

#### Drawing Details


Project Number	007-03-US-PV
Project Type	Photovoltaic Roof Mount System
Drawing Name	Solar Permit Document
Drawing Number	23014-US-Tyrell_hicks-PV_Permit-00
Drawing Type	Preliminary Design

REV.	DATE	Drawing Type	DESIGN	CHECK	APPROVAL

Sheet No.	PV-00
Sheet Name	COVER SHEET
Sheet Size	ANSI B 11" X 1 <i>7</i> "

#### APPLICABLE CODES

2017 NATIONAL ELECTRICAL CODE (NEC)
2020 INTERNATIONAL BUILDING CODE (IBC)
2020 INTERNATIONAL RESIDENTIAL CODE (IRC)
2020 INTERNATIONAL MECHANICAL CODE (IMC)
2020 INTERNATIONAL PLUMING CODE (IPC)
2020 INTERNATIONAL ENERGY CONSERVATION CODE (IECC)

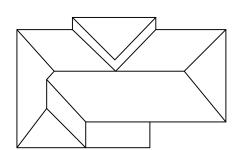


**AERIAL VIEW** 



**HOUSE AREA** 

SCALE: NTS

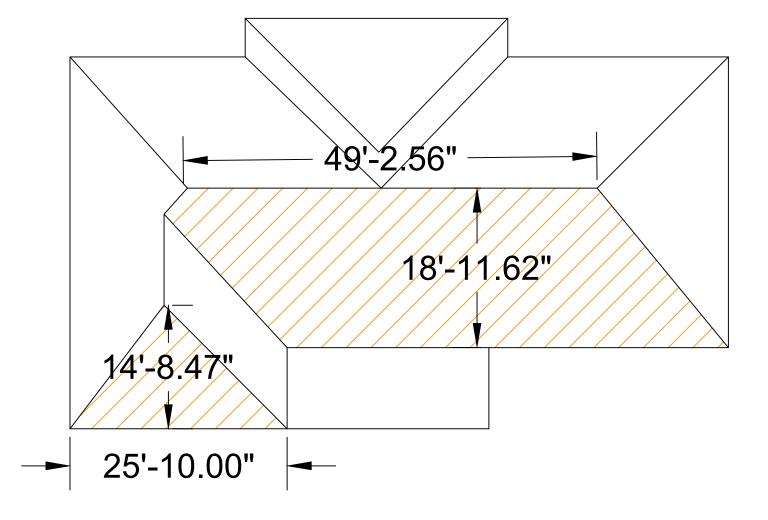

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# Project Data

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> 3505 Medulla Rd. Plant City FL 33566

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Drawing Number	23014-US-Tyrell_hicks-PV_Permit-00
Drawing Type	Preliminary Design

#### Revisions

REV.	DATE	Drawing Type	DESIGN	CHECK	APPROVAL

Sheet No.	PV-01
Sheet Name	SITE & ROOF PLAN
Sheet Size	ANSI B 11" X 17"


SITE PLAN AND ROOF PLAN

## MODULE TYPE, DIMENSIONS, & WEIGHT:

**ROOF PLAN WITH MODULES** 

- 1) NUMBER OF MODULES: 30 MODULES
- MODULE TYPE: Boviet BVM6610M-370S-H-HC-BF
   MODULE WEIGHT: 48.50 Lb
- 4) SOLAR PANEL AREA: 20.20 Sq. foot

ROOF DESCRIPTION				
ROOF TYPE		Trapezoi	idal	
ROOF	TILT	AZIMUTH		
# 1	14°	180°		
#2	14°	180°		

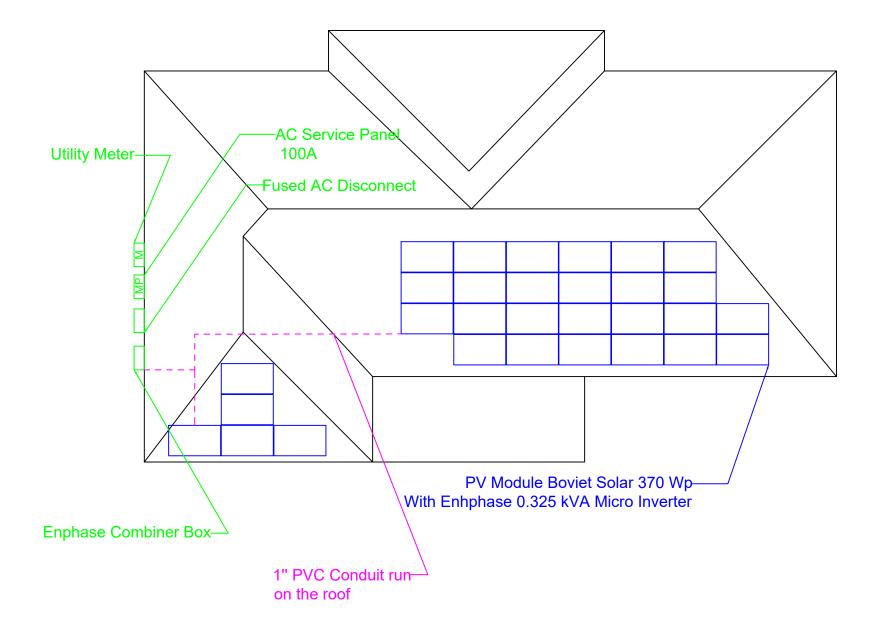

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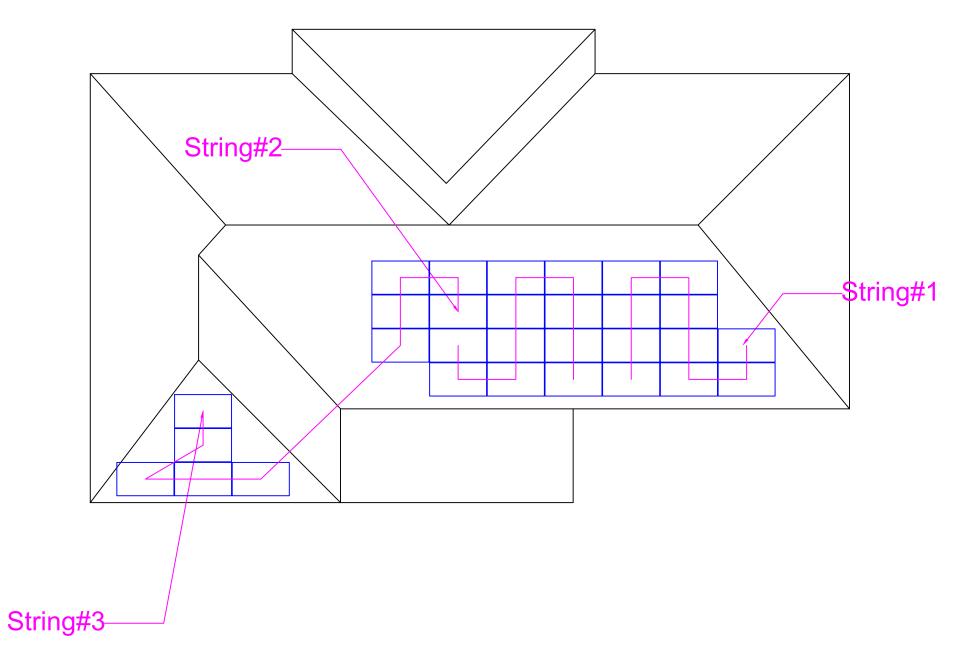
# Drawing Details

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Drawing Number	23014-US-Tyrell_hicks-PV_Permit-00
Drawing Type	Preliminary Design

REV.	DATE	Drawing Type	DESIGN	CHECK	APPROVAL

Sheet No.	PV-02
Sheet Name	ROOF & MODULES PLAN
Sheet Size	ANSI B 11" X 17"

BILL OF MATERIALS		
EQUIPMENT	QTY	DESCRIPTION
SOLAR PV MODULES	30	BOVIET BVM6610M-370S-H-HC-BF
INVERTER	30	ENPHASE IQM-72-2
FUSED AC DISCONNECT	1	AC DISCONNECT 240V, 50A
LOAD CENTER	1	Enphase IQ Combiner 4
ROOF BRACKET	174	ProteaBracket™ AL
MID CLAMPS	75	S-5-PVKIT®2.0 Edge Grab
END CLAMPS	99	S-5-PVKIT®2.0 Edge Grab



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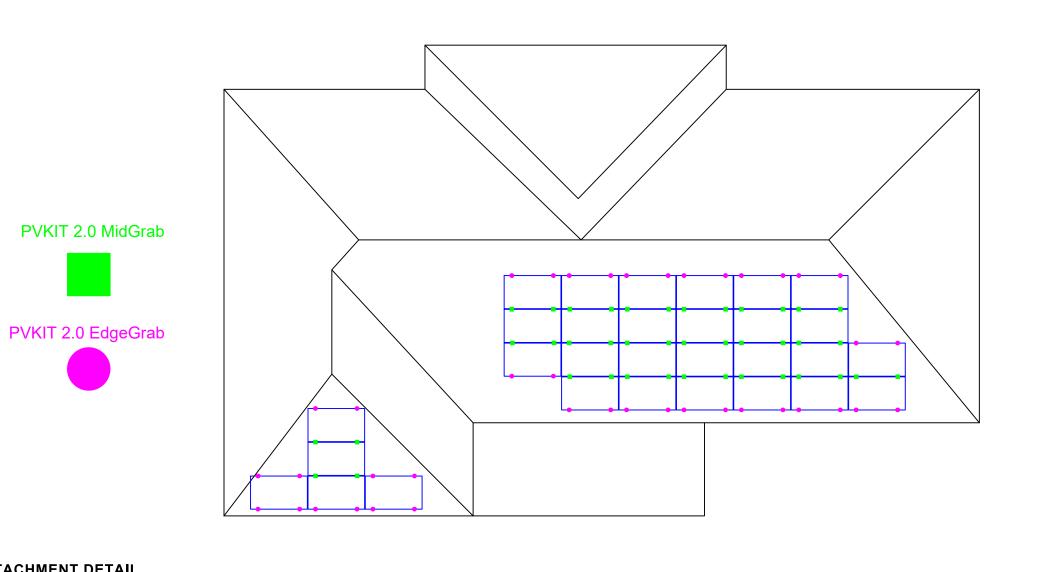
Project Number	007-03-US-PV
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Drawing Name	Solar Permit Document
Drawing Number	23014-US-Tyrell_hicks-PV_Permit-00
Drawing Type	Preliminary Design

## Revisions

REV.	DATE	Drawing Type	DESIGN	CHECK	APPROVAL

Sheet No.	PV-03
Sheet Name	STRING LAYOUT
Sheet Size	ANSI B 11" X 17"

STRING LAYOUT



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# Drawing Details


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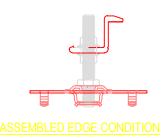
## Revisions

REV.	DATE	Drawing Type	DESIGN	CHECK	APPROVAL


Sheet No.	PV-04
Sheet Name	MOUNTING LAYOUT
Sheet Size	ANSI B 11" X 17"


## ATTACHMENT DETAIL



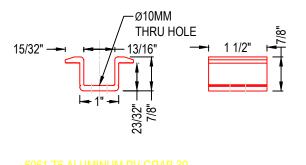



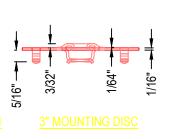

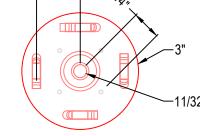


ATTACHMENT DETAIL (ENLARGED SECTION VIEW)

30 BOVIET BVM6610M-370S-H-HC-BF 3 STRING OF 12,6 MODULES CON. IN SERIES

SYSTEM SIZE 9.75 kVA

Conduits Schedule								
No.	No. Conduits Conductor Neutral Ground							
1	1" PVC	(3) AWG#12, 1 Core RAW QD CABLE	(3) AWG#12, 1 Core RAW QD CABLE	(1) AWG #12 THWN-2 GND				
2	1" PVC	(3) AWG#6, 1 Core THWN- 2	(1 AWG#6, 1 Core THWN- 2	(1) AWG#6, 1 Core GND- 2				

CONDUCTOR SIZING CALULATIONS								
CIRCUIT DESCRIPTION	CURRENT	Imax (690.8(A))	lcont (690.8(B)(1) calc)	SPECIFIED CONDUCTOR	AMPACITY @ 90c	AMBIENT TEMP c	CURRENT CARRYING COND.	COND. OF USE APPLIED (690.8(B)(2) calc)
From roof Combiner Box to Enphase IQ 4	13.5000	13.5000	16.8800	#12, THWN	25	45	1 TO 3	21.7500
From Enphase IQ To fused Disconnect	40.5000	40.5000	50.6400	#6, THWN	85	45	1 TO 3	73.9500

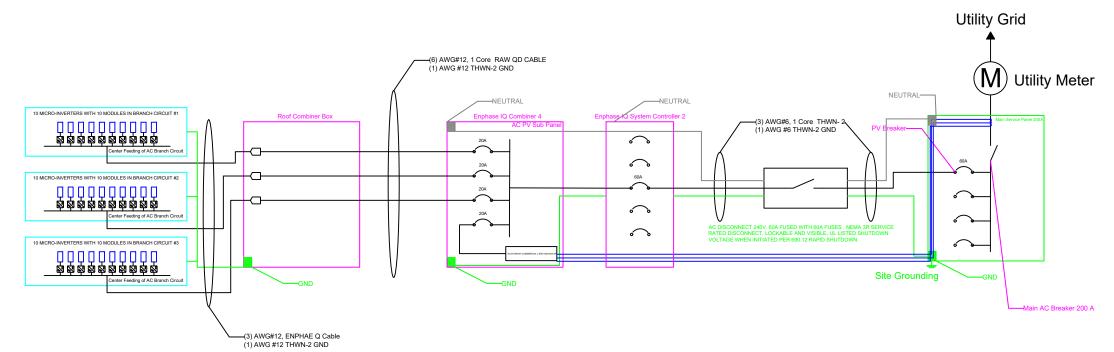

## **ELECTRICAL SINGLE LINE DIAGRAM**

SCALE: NT

## **BEAM SEQUENT**

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# Project Data

Tyrell Hicks Residence PV System 27°58'53.33"N 82° 3'41.81"W

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## Drawing Details

Project Number	007-03-US-PV
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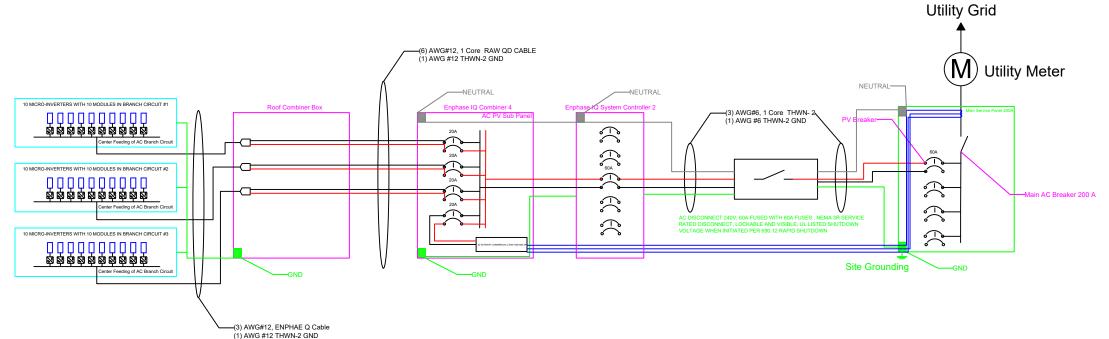
Sheet No.	PV-05
Sheet Name	SINGLE-LINE DIAGRAM
Sheet Size	ANSI B 11" X 17"

30 BOVIET BVM6610M-370S-H-HC-BF 3 STRING OF 12,6 MODULES CON. IN SERIES

SYSTEM SIZE 9.75 kVA

Conduits Schedule								
No.	No. Conduits Conductor Neutral							
1	1" PVC	(3) AWG#12, 1 Core RAW QD CABLE	(3) AWG#12, 1 Core RAW QD CABLE	(1) AWG #12 THWN-2 GND				
2	1" PVC	(3) AWG#6, 1 Core THWN- 2	(1 AWG#6, 1 Core THWN- 2	(1) AWG#6, 1 Core GND- 2				

CONDUCTOR SIZING CALULATIONS								
CIRCUIT DESCRIPTION	CURRENT	Imax (690.8(A))	lcont (690.8(B)(1) calc)	SPECIFIED CONDUCTOR	AMPACITY @ 90c	AMBIENT TEMP c	CURRENT CARRYING COND.	COND. OF USE APPLIED (690.8(B)(2) calc)
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#### **ELECTRICAL SINGLE LINE DIAGRAM**

SCALE: NT

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	Drawing Type	Preliminary Design

REV.	DATE	Drawing Type	DESIGN	CHECK	APPROVAL

Sheet No.	PV-06
Sheet Name	THREE-LINE DIAGRAM
Sheet Size	ANSI B 11" X 17"







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Drawing Type	Preliminary Design

REV.	DATE	Drawing Type	DESIGN	CHECK	APPROVAL

Sheet No.	PV-07
Sheet Name	METER & PANEL PHOTOS
Sheet Size	ANSI B 11" X 17"

INSTALL ON THE UTILITY METER

WARNING
THIS SERVICE METER
IS ALSO SERVED BY A
PHOTOVOLTAIC SYSTEM

INSTALL ON THE MAIN BREAKER PANEL

RAPID SHUTDOWN SWITCH FOR SOLAR PV SYSTEM

TO BE INSTALLED IN ACCORDANCE WITH SECTION 690.56(C):

CAUTION: SOLAR ELECTRIC SYSTEM CONNECTED

PHOTOVOLTAIC SYSTEM
AC DISCONNECT
OPERATING VOLTAGE 240 VOLTS

OPERATING CURRENT 60 AMPS

WARNING TURN OFF PHOTOVOLTAIC AC DISCONNECT PRIOR TO WORKING INSIDE PANEL

INSTALL INSIDE THE MAIN BREAKER PANEL, NEXT TO THE SOLAR BREAKER

PV SOLAR BREAKER DO NOT RELOCATE THIS OVERCURRENT DEVICE INSTALL ON THE AC DISCONNECT

# PHOTOVOLTAIC SYSTEM AC DISCONNECT

OPERATING VOLTAGE 240 VOLTS
OPERATING CURRENT 60 AMPS

PV SYSTEM DISCONNECT FOR UTILITY OPERATION

# **WARNING**

ELECTRIC SHOCK HAZARD


DO NOT TOUCH TERMINALS

TERMINALS ON BOTH THE LINE AND

LOAD SIDES MAY BE ENERGIZED


IN THE OPEN POSITION

# SOLAR PV SYSTEM EQUIPPED WITH RAPID SHUTDOWN

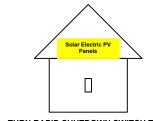

TURN RAPID SHUTDOWN SWITCH TO THE OFF POSITION TO SHUTDOWN THE PV SYSTEM AND REDUCE THE SHOCK HAZARD IN THE ARRAY

#### INSTALL ON THE AC DISCONNECT

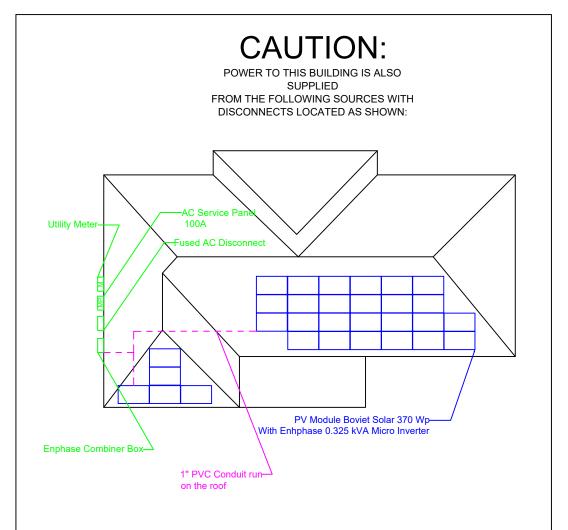

#### BEAM SEQUENT

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REV.	DATE	Drawing Type	DESIGN	CHECK	APPROVAL

Sheet No.	PV-08
Sheet Name	WARNING SIGNS
Sheet Size	ANSI B 11'' X 17''